

FRONT ELEVATION

TITLE NOT THUILDING STORMWATER ABSORPTION SEWER MAIN SEWER MAIN 15.680 m 11.208 m

SITE DETAILS

LOT A DP 386514 H/No 144 CHESTER HILL ROAD

SITE AREA 604.8 sqm

EXISTING HOUSE AREA 80.33 sqm

ADDITIONAL HOUSE AREA 133.9 sqm

TOTAL HOUSE AREA 214.23 sqm

ZONING R2 LOW DENSITY RESIDENTIAL

SITE COVER 33.55%

FLOOR SPACE RATIO 0.5:1 = 302.5 NEW G/F 214.23 sqm

LANDSCAPE AREA 339 sqm = 56%

MAX HEIGHT ALLOWED 9.0M PROPOSED 8.21M

BASIX CERTIFICATE NUMBER A1788828



GOOGLE MAP LOCATION PLAN

PROPOSED ALTERATIONS & ADDITIONS TO RESIDENCE 144 CHESTER HILL ROAD, BASE HILL NSW 2197

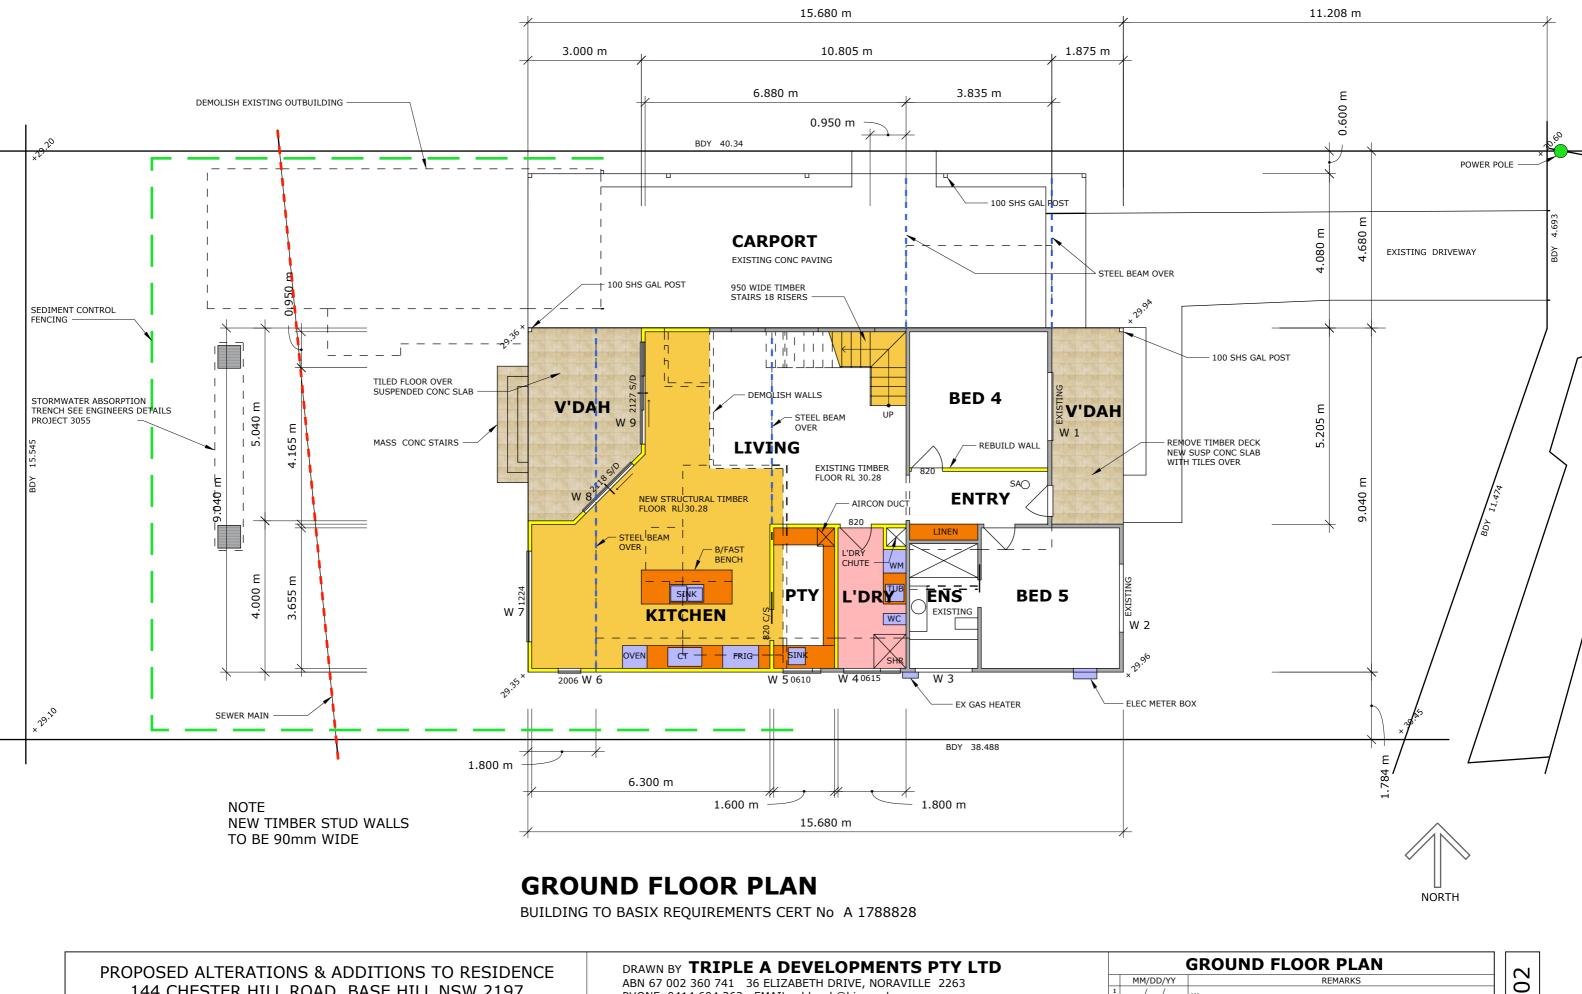
NORTH

OR CLAIRE CHURTON & ASSEM EWAIS

ABN 67 002 360 741 36 ELIZABETH DRIVE, NORAVILLE 2263 PHONE 0414 604 362 EMAIL ablazek@bigpond.com	DRAWN BY TRIPLE A DEVELOPMENTS PTY LTD
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	PHONE 0414 604 362 EMAIL ablazek@bigpond.com

SCALE	1: 200	DATE	14 APRIL 2025	DRAWN BY	TONY BLAZEK

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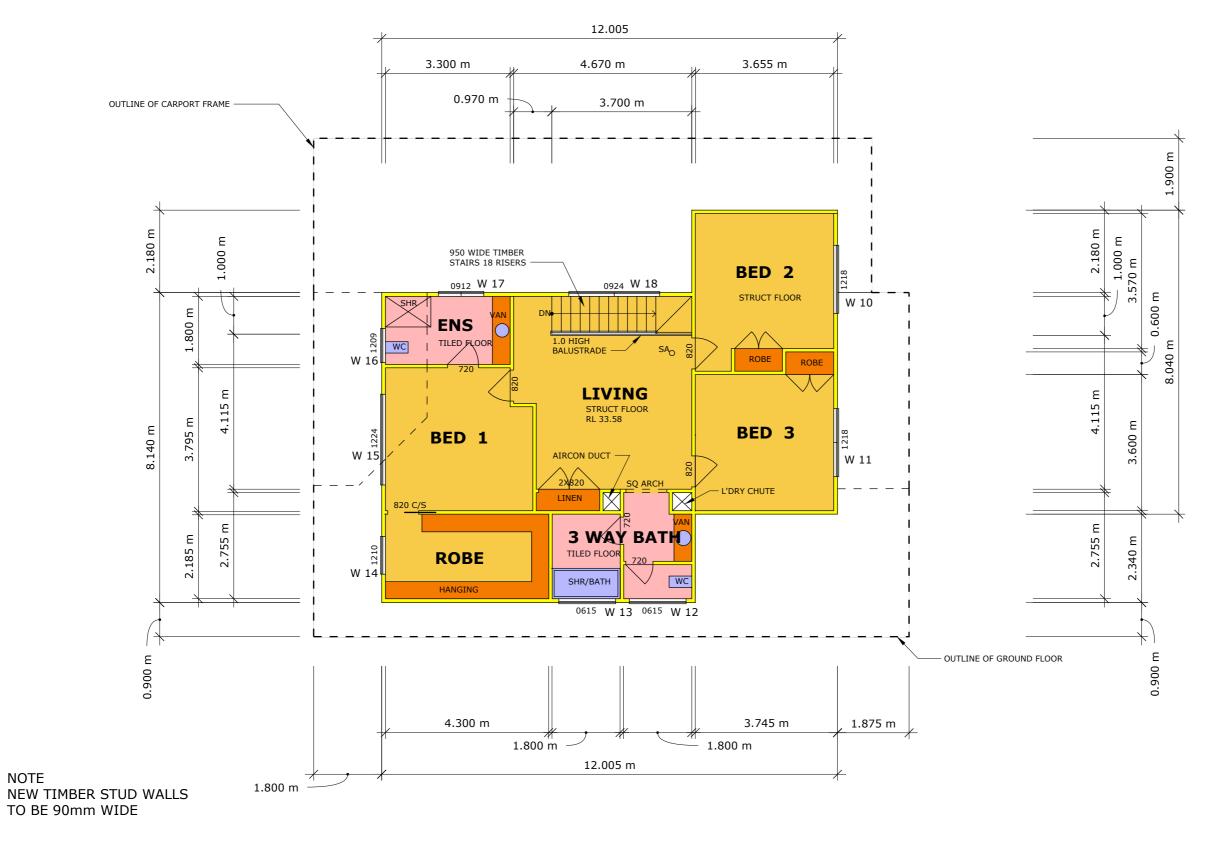
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FIRST FLOOR PLAN

BUILDING TO BASIX REQUIREMENTS CERT No A 1788828

PROPOSED ALTERATIONS & ADDITIONS TO RESIDENCE
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EASTERN VIEW







NORTHERN VIEW

SOUTHERN VIEW

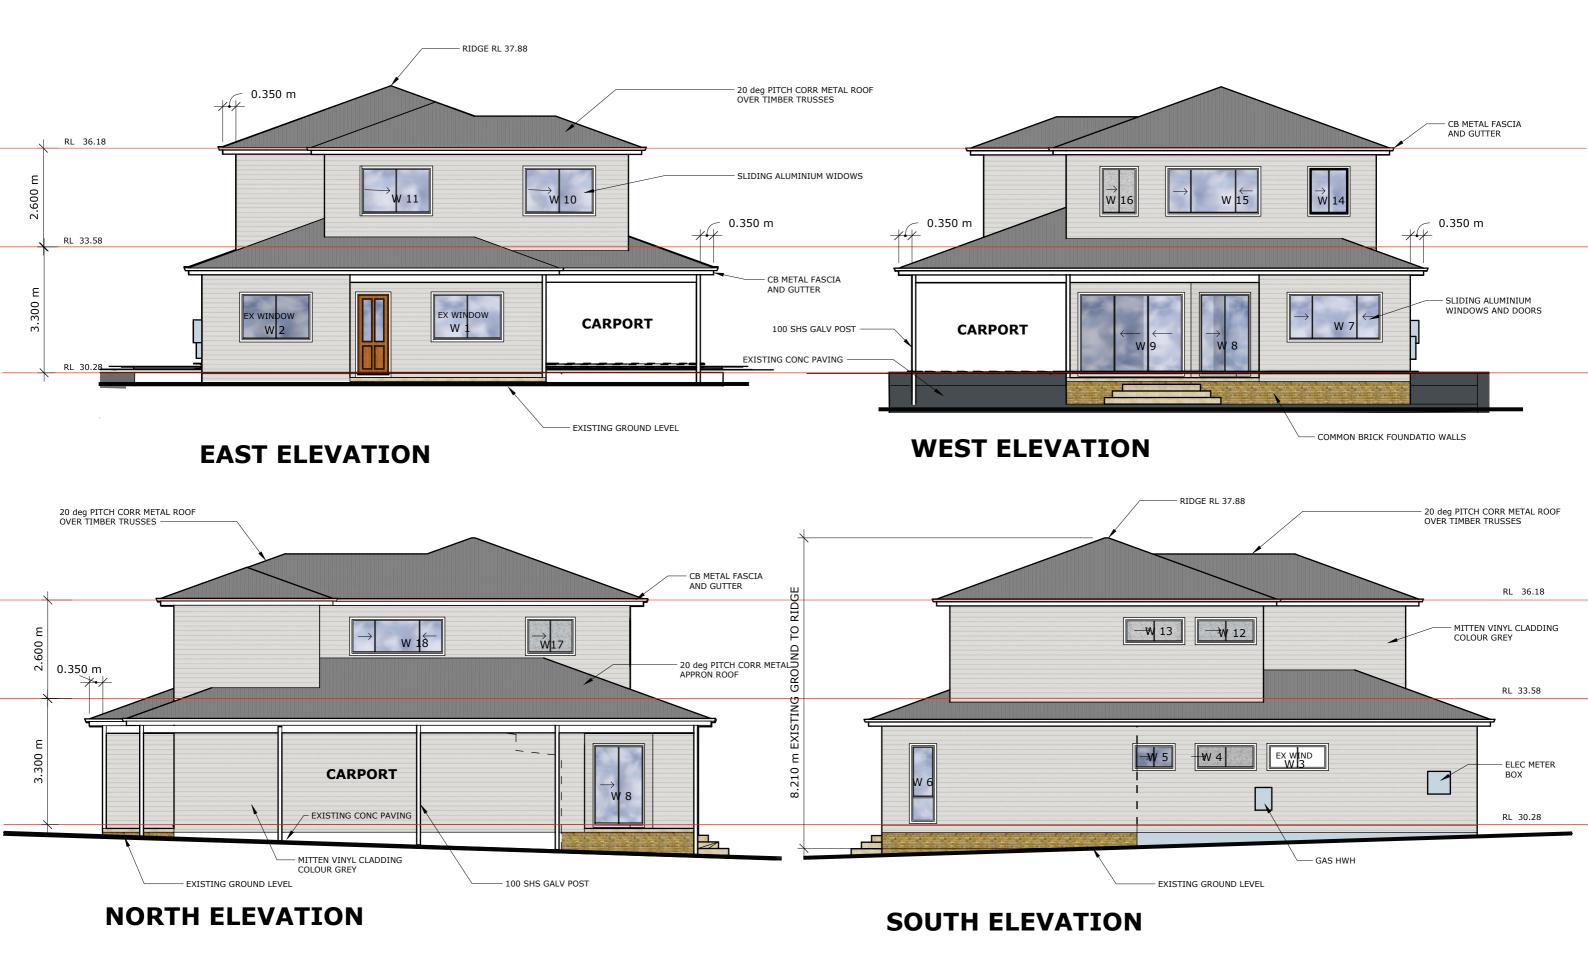
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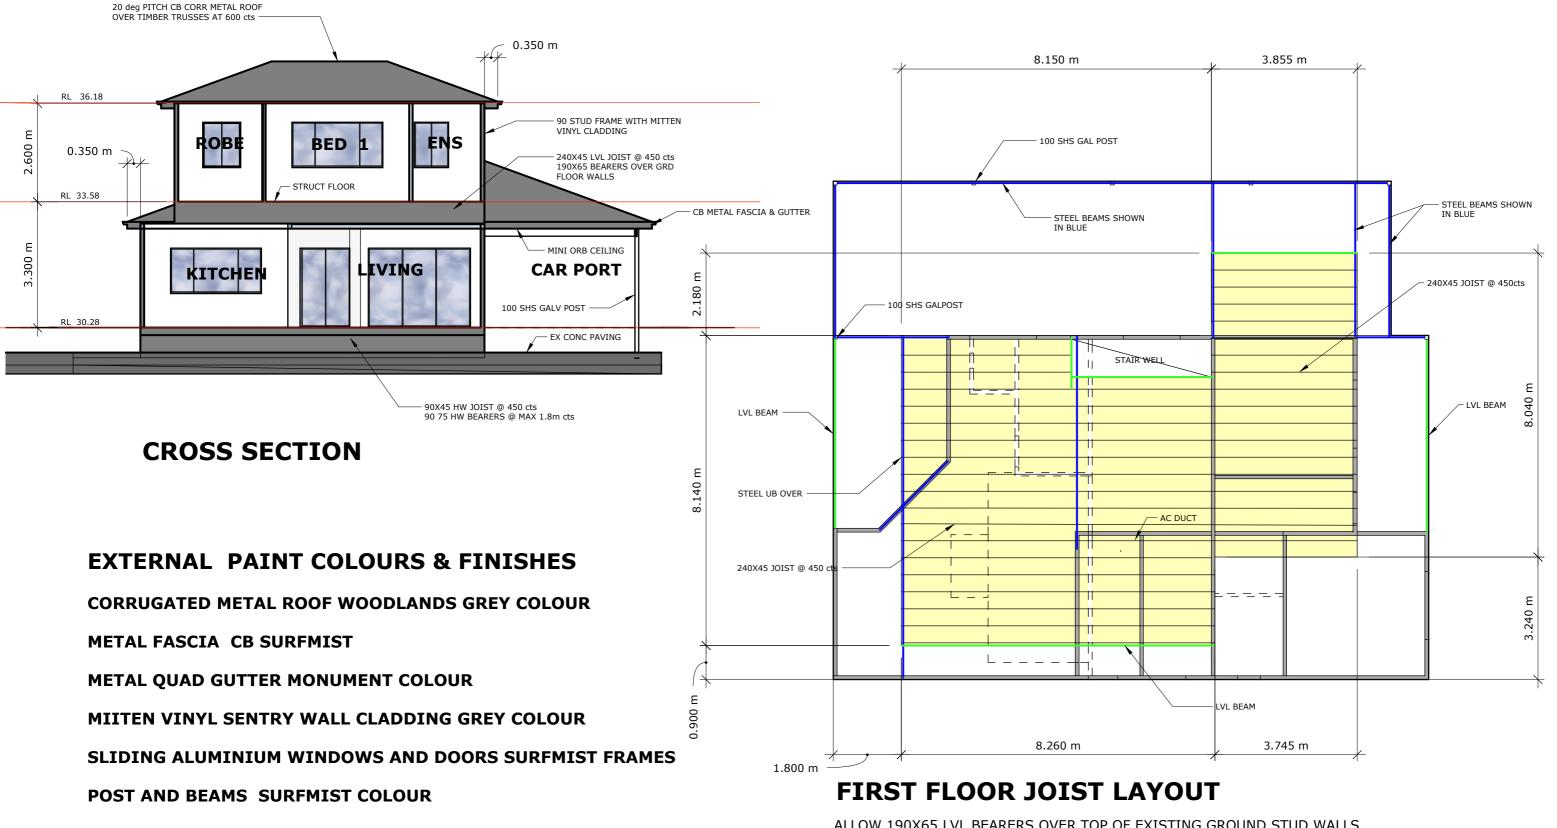
SCALE 1: 100 DATE 14 APRIL 2025 DRAWN BY TONY BLAZEK

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ALLOW 190X65 LVL BEARERS OVER TOP OF EXISTING GROUND STUD WALLS

PROPOSED ALTERATIONS & ADDITIONS TO RESIDENCE 144 CHESTER HILL ROAD, BASE HILL NSW 2197

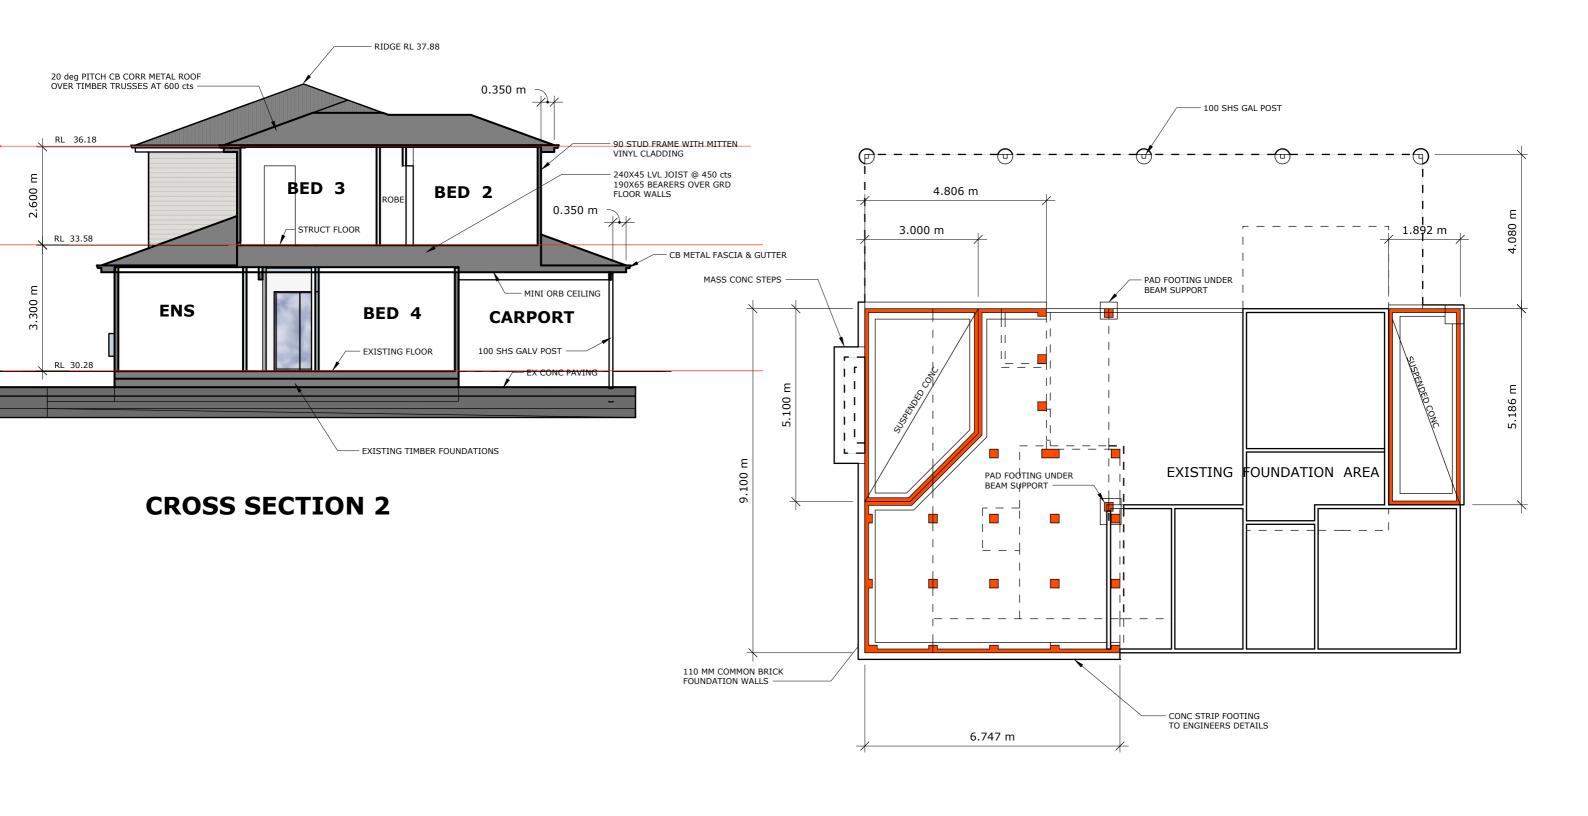
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FOUNDATION PLAN

NEW FOUNDATION 90X45 HW JOIST @ 450 cts AND 90X75 HW BEARERS @ MAX 1.8M cts 18MM STRUCTURAL SHEET FLOORING

CONCRETE STRIP FOOTINGS SLABS AND STRUCTURAL BEAMS TO ENGINEERS DETAILS

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BASIX Certificate Alterations and Additions

Lighting

The applicant must ensure a minimum of 40% of new or altered light fixtures are fitted with fluorescent, compact fluorescent, or light-emitting-diode (LED) lamps.

Firtures

The applicant must ensure new or altered showerheads have a flow rate no greater than 9 litres per minute or a 3 star water rating. The applicant must ensure new or altered toilets have a flow rate no greater than 4 litres per average flush or a minimum 3 star water rating. The applicant must ensure new or altered taps have a flow rate no greater than 9 litres per minute or minimum 3 star water rating.

Insulation requirements

The applicant must construct the new or altered construction (floor(s), walls, and ceilings/roofs) in accordance with the specifications listed in the table below, except that a) additional insulation is not required where the area of new construction is less than 2m2, b) insulation specified is not required for parts of altered construction where insulation already exists.

Construction	Additional Insulation required (R-value	Other Specifications
Suspended floor with open subfloor: framed (R0.7)	R0.8 (down) (or R1.50 including construction)	
Suspended floor with enclosed subfloor: framed (R0.7)	R0.6 (down) (or R1.30 including construction)	
Floor above existing dwelling or building	nil	
external wall: framed (weatherboard, fibro, metal clad)	R1.30 (or R1.70 including construction)	
Flat ceiling, pitched roof	ceiling: R2.25 (up), roof: foil/sarking	Light (solar absorptance < 0.475)

Windows and glazed doors

The applicant must install the windows, glazed doors and shading devices, in accordance with the specifications listed in the table below. Relevant overshadowing specifications must be satisfied for each window and glazed door. The following requirements must also be satisfied in relation to each window and glazed door: Each window or glazed door with standard aluminium or timber frames and single clear or toned glass may either match the description, or, have a U-value and a Solar Heat Gain Coefficient (SHGC) no greater than that listed in the table below. Total system U-values and SHGCs must be calculated in accordance with National Fenestration Rating Council (NFRC) conditions. Each window or glazed door with improved frames, or pyrolytic low-e glass, or clear/air gap/clear glazing, or toned/air gap/clear glazing must have a U-value and a Solar Heat Gain Coefficient (SHGC) no greater than that listed in the table below. Total system U-values and SHGCs must be calculated in accordance with National Fenestration Rating Council (NFRC) conditions. The description is provided for information only. Alternative systems with complying U-value and SHGC may be substituted. For projections described in millimetres, the leading edge of each eave, pergola, verandah, balcony or awning must be no more than 500 mm above the head of the window or glazed door and no more than 2400 mm above the sill. For projections described as a ratio, the ratio of the projection from the wall to the height above the window or glazed door sill must be at least that shown in the table below. Pergolas with polycarbonate roof or similar translucent material must have a shading coefficient of less than 0.35. Pergolas with fixed battens must have battens parallel to the window or glazed door above which they are situated, unless the pergola also shades a perpendicular window. The spacing between battens must not be more than 50 mm. Overshadowing buildings or vegetation must be of the height and distance from the centre and the base of the window

Note: All details on this summary should be cross checked with the actual BASIX Certificate before ordering

MO decide en		0	Oversi	hadowing		1	
Window/door no.	Orientation	Area of glass inc. frame (m2)	Height Distance (m) (m)		Shading device	Frame and glass type	
W4	s	0.9	0.0	0.0	eave/verandah/pergola/balcony >=450 mm	Standard aluminium, single clear, (or U- value: 7.63, SHGC: 0.75)	
W5	s	0.9	0.0	0.0	eave/verandah/pergola/balcony >=450 mm	Standard aluminium, single clear, (or U- value: 7.63, SHGC: 0.75)	
W6	s	1.2	0.0	0.0	eave/verandah/pergola/balcony >=450 mm	Standard aluminium, single clear, (or U- value: 7.63, SHGC: 0.75)	
W7	W	2.88	0.0	0.0	eave/verandah/pergola/balcony >=450 mm	Standard aluminium, single Lo-Tsol low-e, (or U-value: 5.6 SHGC: 0.36	
W8	NW	3.78	0.0	0.0	eave/verandah/pergola/balcony >=900 mm	Standard aluminium, single clear, (or U- value: 7.63, SHGC: 0.75)	
W9	W	5.67	0.0	0.0	eave/verandah/pergola/balcony >=900 mm	Standard aluminium, single clear, (or U- value: 7.63, SHGC: 0.75)	
W10	E	2.16	0.0	0.0	eave/verandah/pergola/balcony >=450 mm	Standard aluminium, single pyrolytic low E, (or U-value: 5.7 SHGC: 0.47	
W11	E	2.16	0.0	0.0	eave/verandah/pergola/balcony >=450 mm	Standard aluminium, single pyrolytic low E, (or U-value: 5.7 SHGC: 0.47	
W12	s	0.9	0.0	0.0	eave/verandah/pergola/balcony >=450 mm	Standard aluminium, single clear, (or U- value: 7.63, SHGC: 0.75)	
W13	s	0.9	0.0	0.0	eave/verandah/pergola/balcony >=450 mm	Standard aluminium, single clear, (or U- value: 7.63, SHGC: 0.75)	
W14	W	1.2	0.0	0.0	eave/verandah/pergola/balcony >=450 mm	Standard aluminium, single Lo-Tsol low-e, (or U-value: 5.6 SHGC: 0.36	
W15	W	2.88	0.0	0.0	eave/verandah/pergola/balcony >=450 mm	Standard aluminium, single Lo-Tsol low-e, (or U-value: 5.6 SHGC: 0.36	
W16	W	1.08	0.0	0.0	eave/verandah/pergola/balcony >=450 mm	Standard aluminium, single Lo-Tsol low-e, (or U-value: 5.6 SHGC: 0.36	
W17	N	1,08	0.6	5.7	projection/height above sill ratio >=0.29	Standard aluminium, single clear, (or U- value: 7.63, SHGC: 0.75)	
W18	N	2.16	2.7	9.7	projection/height above sill ratio >=0.29	Standard aluminium, single clear, (or U- value: 7.63, SHGC: 0.75)	

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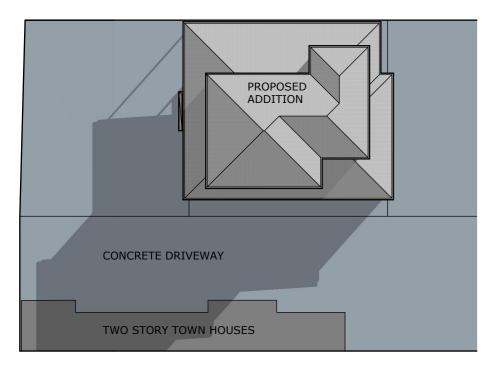
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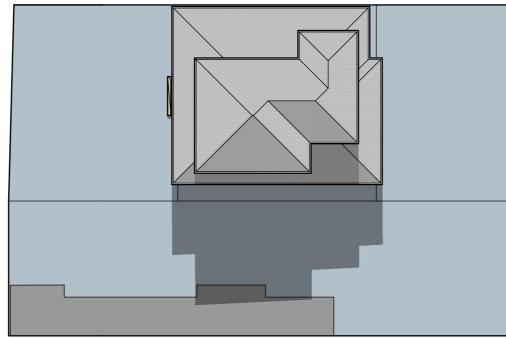
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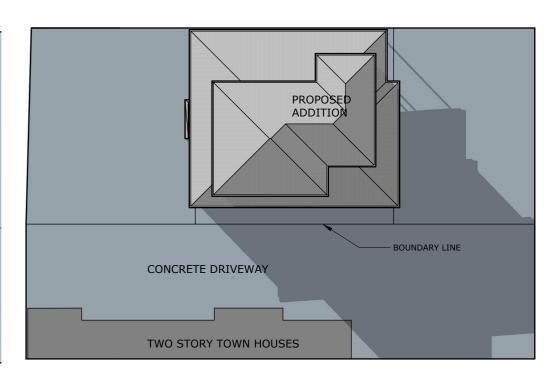
Certificate number: A1788828 - 25, March 2025

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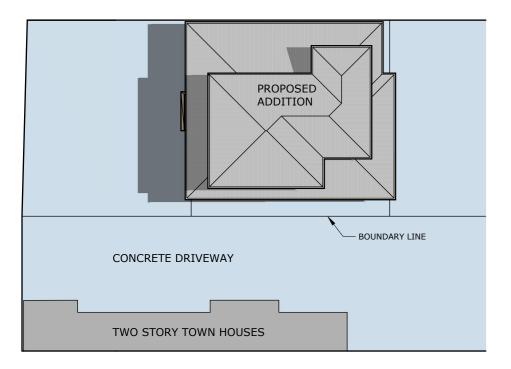
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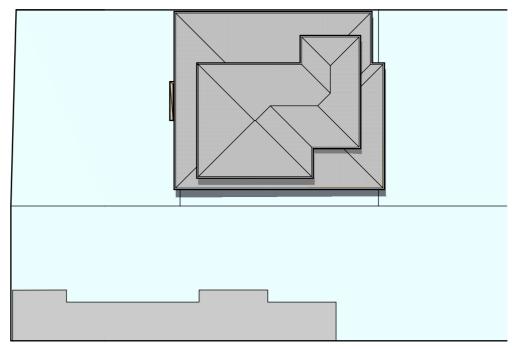


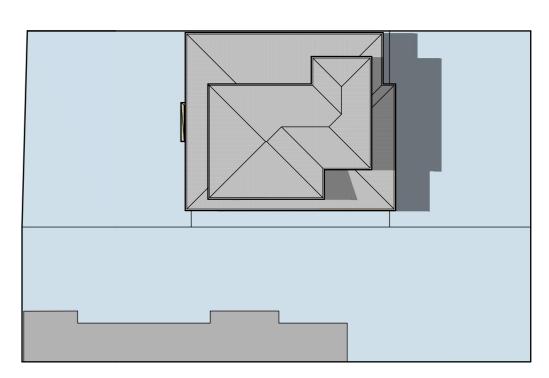




9 am WINTER 12 NOON WINTER 3 pm WINTER







9 am SUMMER 12 NOON SUMMER

3 pm SUMMER

NORTH

PROPOSED ALTERATIONS & A	ADDITIONS TO RESIDENCE
144 CHESTER HILL ROAD	, BASE HILL NSW 2197

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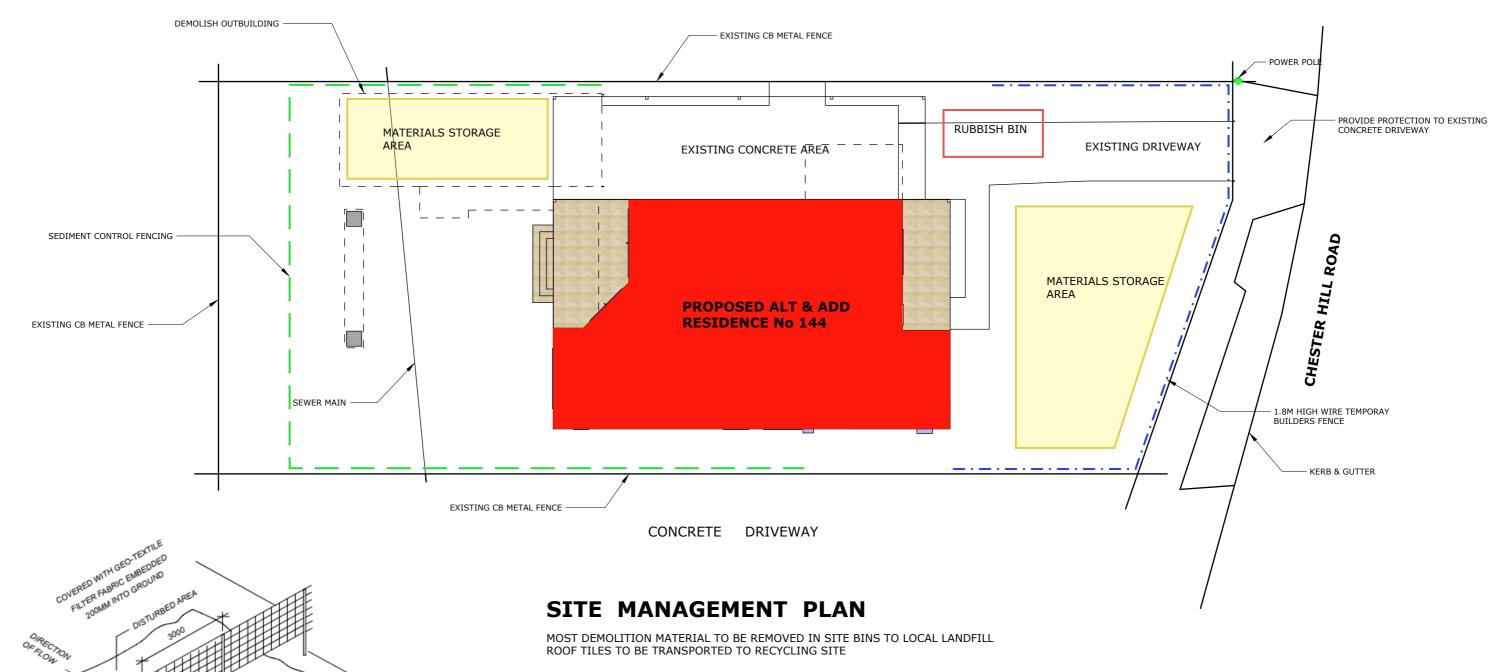
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EXISTING OUTBUILDING TO BE DEMOLIHED INC CONCRETE SLAB

REMOVE EXISTING ROOF TILES AND ROOF FRAME, CEILING JOIST TO REMAIN

DEMOLISH REAR WALLS OF BUILDING, REMOVE FRONT & BACK VERANDAHS

REMOVE EXISTING VINYL WALL CLADDING

EXCAVATE NEW CONC FOOTINGS , BUILD BRICK FOUNDATIONS & POUR NEW SLABS

BUILD NEW GRD FLOOR, WALL FRAMES, BUILD FIRST FLOOR FRAME AND WALLS

BUILD NEW ROOF FRAME AND EAVES INSTALL NEW CB CORR METAL ROOF



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SEDIMENT FENCE DETAIL

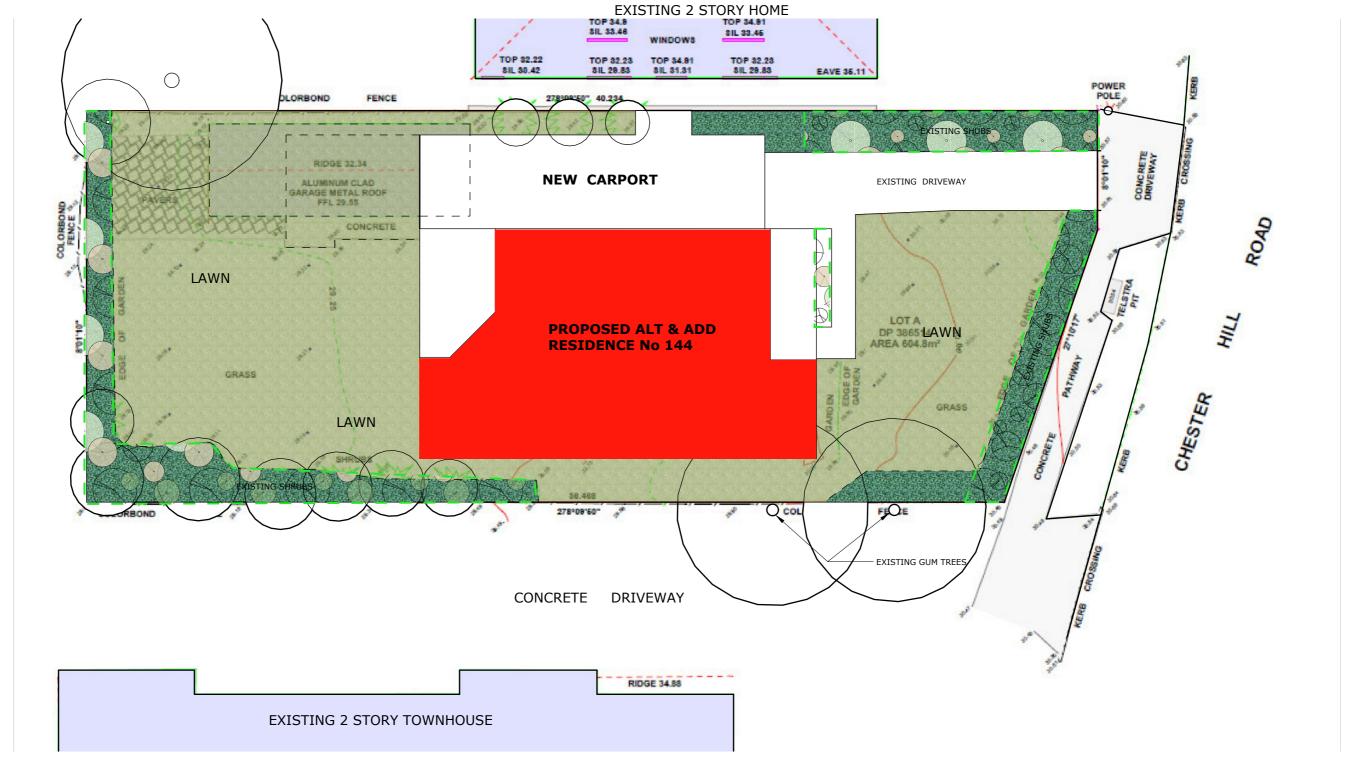
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	SITE	SITE MANAGEMENT PLAN				
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LANDSCAPE PLAN

EXISTING LAWNS, SHRUBS AND TREES TO REMAIN DEMOLISH EXISTING OUTBUILDING, FLOOR SLAB AND PATHS AND RETURN THIS AREA TO LAWN LANDSCAPE AREA IS 339 sqm = 56%



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LANDSCAPE PLAN

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